
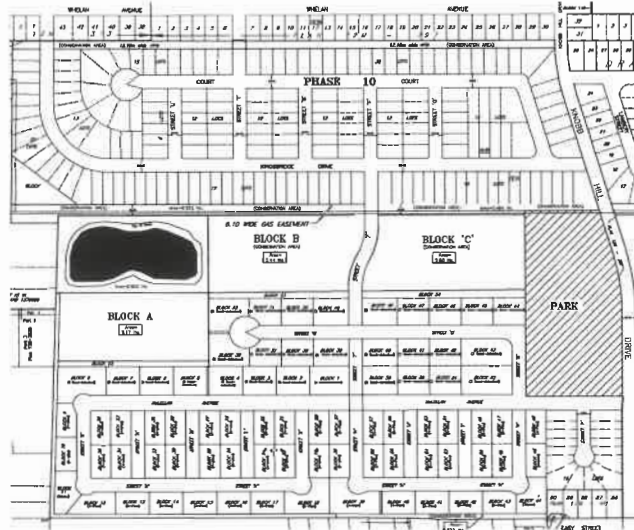


KINGSBRIDGE DEVELOPMENT SANITARY TRUNK SEWER

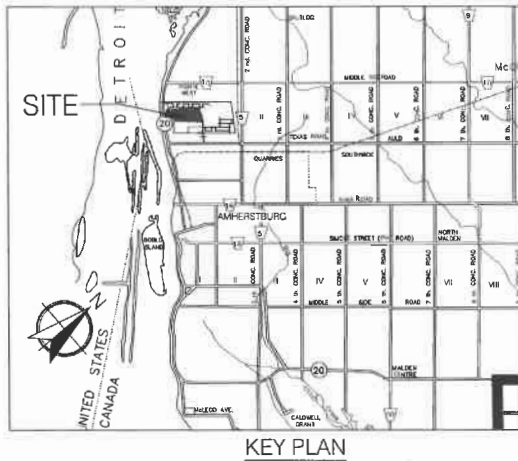

Sheet List	
Sheet Number	Sheet Title
---	TITLE PAGE
1	SANITARY SEWER PLAN
2	SANITARY SEWER PLAN
3	PLAN AND PROFILE 0+1000 TO 0+120
4	PLAN AND PROFILE 0+120 TO 0+252
5	PLAN AND PROFILE 0+300 TO 0+500
6	PLAN AND PROFILE 0+600 TO 0+132
7	PLAN AND PROFILE 0+132 TO 0+285.85
8	PLAN AND PROFILE 0+000 TO 0+130
9	PLAN AND PROFILE 0+130 TO 0+280.85
10	PLAN AND PROFILE 0+000 TO 0+127.92
11	PLAN AND PROFILE 0+000 TO 0+170
12	SANITARY SEWER SUBANCE PLAN
13	SANITARY SEWER SUBANCE PLAN
14	SANITARY DESIGN SHEET
15	DETAILS

DESCRIPTION	LEGEND	
	EXISTING AND FUTURE	NEW
STORM SEWER		
SANITARY SEWER		
WATER MAIN		
STORM SERVICE		
SANITARY SERVICE		
WATER SERVICE		
FIRE HYDRANT & WATER VALVE		
GAS MAIN		
CATCH BASIN		
STORM MANHOLE		
SANITARY MANHOLE		
WATER VALVE		
SP ELEVATIONS		
STREET LIGHTS		



TEMPORARY BENCHMARK : BM #1 - TOP OF FIRE HYDRANT (TOP OF NUT IN FRONT OF MUN # 302 AND 305 WELSH AVENUE - ELEVATION = 184.500

NOTE:
CONSULTANT/DEVELOPER TO GPS SEWERS, WATERMAIN, MANHOLES, MAIN LINE VALVES AND SERVICES CONNECTIONS AND PROVIDE THE DATA TO ENGINEERS AND PUBLIC WORKS AS PART OF AS-BUILT DRAWING SUBMISSION.



SEE PAGE 4

MATCH LINE

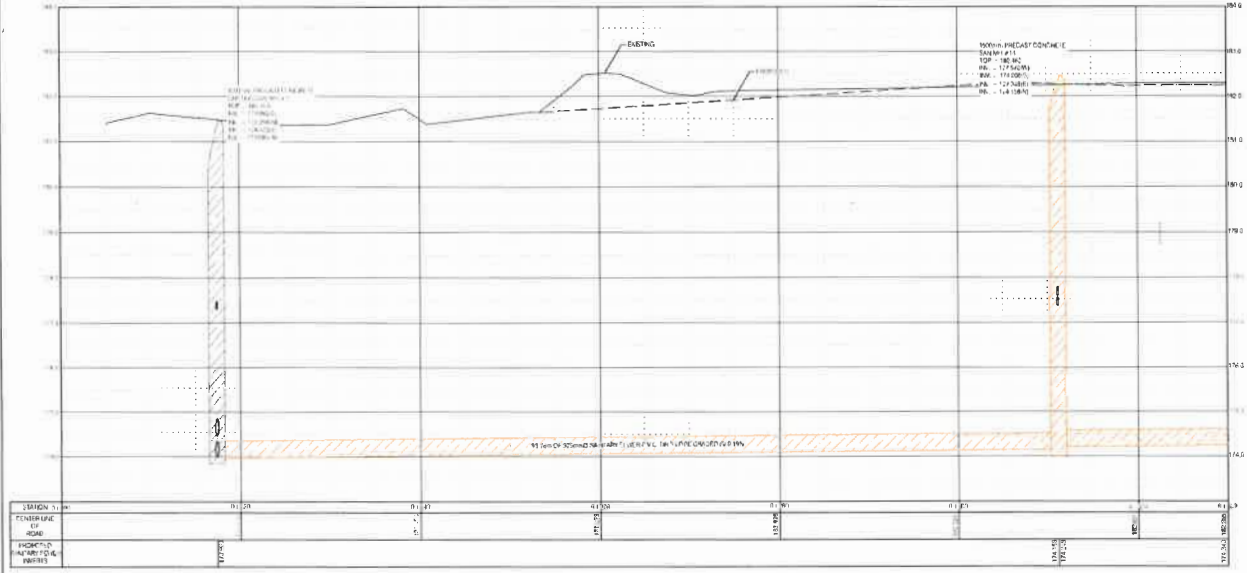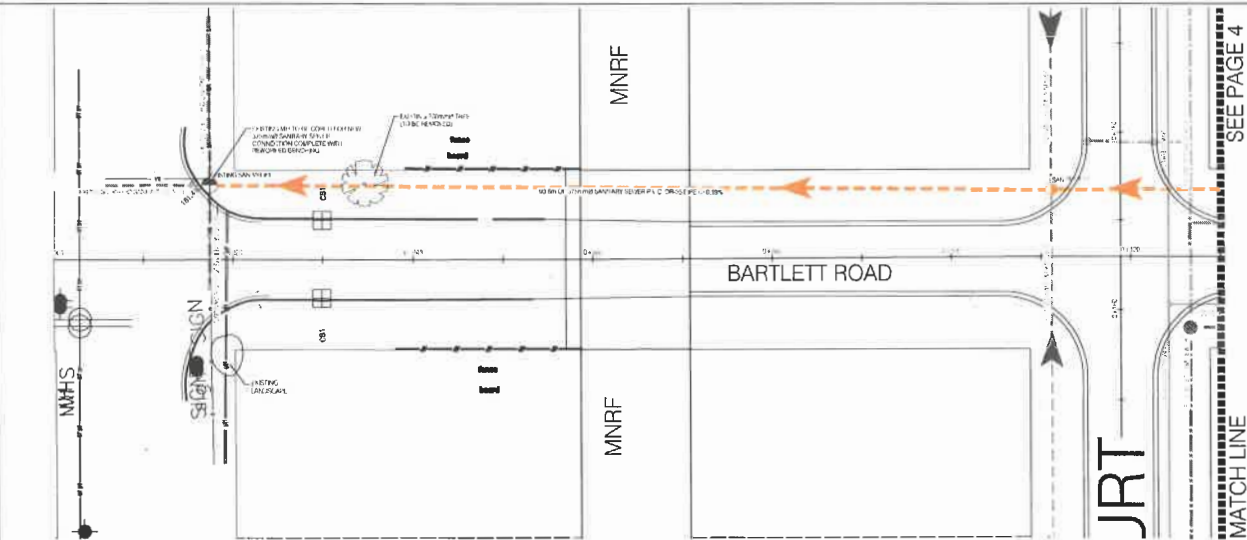

STATION 1	0+00
CENTERLINE OF ROAD	0+00
PROJECT CITY	AMHERSTBURG
PROJECT NUMBER	18-099



DATE: DECEMBER 12, 2018
 MJB
 MARK J. BAIRD, P.E.


DATE	REVISIONS
SEP 11, 2016	REV: CE/BJR/BJ/RYAL
DEC 10, 2016	REV: CE/BJR/BJ/RYAL
SEPTEMBER 14, 2018	REV: CE/BJR/BJ/RYAL
DECEMBER 12, 2018	REV: CE/BJR/BJ/RYAL
JAN 14, 2019	REV: CE/BJR/BJ/RYAL




PROJECT TITLE: KINGSBRIDGE SANITARY TRUNK SEWER
 IN THE TOWN OF AMHERSTBURG
 DATE: 12/12/18
 PLAN AND PROFILE 0+000 TO 0+130

DATE: DECEMBER 12, 2018	PROJECT NO: 18-099
DRAWN BY: T. F. JOHNSON	CHECKED BY: M. J. BAIRD
SCALE: AS SHOWN	SHEET NO: 3

KINGSBRIDGE DEVELOPMENT PHASE 10B/D

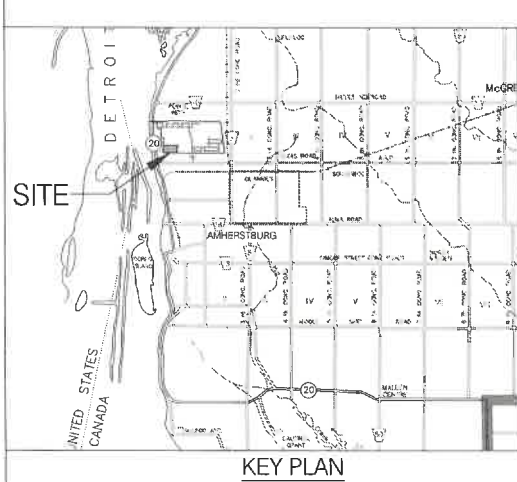

KEY PLAN

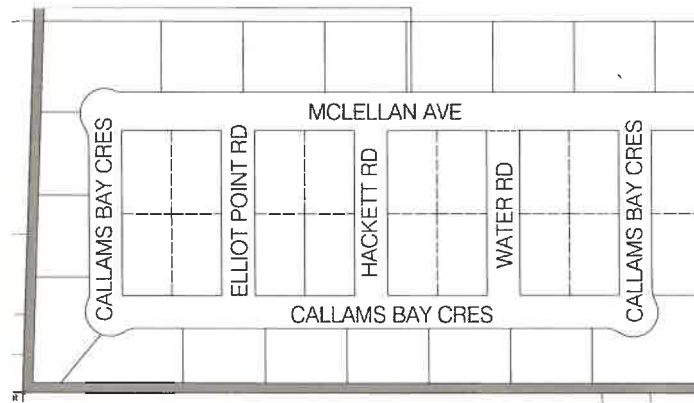

SITE MAP

SHEET LIST	
SHEET No.	SHEET TITLE
--	TITLE PAGE
1	PAVEMENT AND LOT GRADING PLAN
2	STORM SEWER LAYOUT PLAN
3	SANITARY SEWER LAYOUT PLAN
4	WATERMAIN LAYOUT PLAN
5	OVERLAND FLOW ROUTE PLAN
6	MCLELLAN PLAN AND PROFILE 0+000 TO 0+140
7	MCLELLAN PLAN AND PROFILE 0+140 TO 0+280
8	MCLELLAN PLAN AND PROFILE 0+280 TO 0+408
9	CALLAMS PLAN AND PROFILE 0+000 TO 0+147
10	CALLAMS PLAN AND PROFILE 0+000 TO 0+140
11	CALLAMS PLAN AND PROFILE 0+140 TO 0+280
12	CALLAMS PLAN AND PROFILE 0+280 TO 0+342
13	CALLAMS PLAN AND PROFILE 0+000 TO 0+135
14	ELLIOT PLAN AND PROFILE 0+000 TO 0+125
15	HACKETT PLAN AND PROFILE 0+000 TO 0+125
16	WATER PLAN AND PROFILE 0+000 TO 0+125
17	STORMSEWER DRAINAGE PLAN
18	SANITARY DRAINAGE PLAN
19	TOWN DETAILS
20	DETAILS
21	DETAILS

LEGEND		
DESCRIPTION	EXISTING	NEW
STORM SEWER		— (green dashed line)
SANITARY SEWER		— (orange dashed line)
WATER MAIN		— (blue dashed line)
STORM SERVICE		— (blue solid line)
SANITARY SERVICE		— (orange solid line)
WATER SERVICE		— (blue solid line)
FIRE HYDRANT & WATER VALVE	● (black)	● (blue)
GAS MAIN		— (black dashed line)
CATCH BASIN	■ (grey)	■ (black)
STORM MANHOLE	● (black)	● (green)
SANITARY MANHOLE	● (grey)	● (orange)
WATER VALVE	● (grey)	● (blue)
EP ELEVATIONS		▽ (blue)
STREET LIGHTS		* (black)

BENCHMARK
FIRE HYDRANT TOP OF NUT IN FRONT OF MUN
#302 AND WAELSH ELEVATION = 184.980